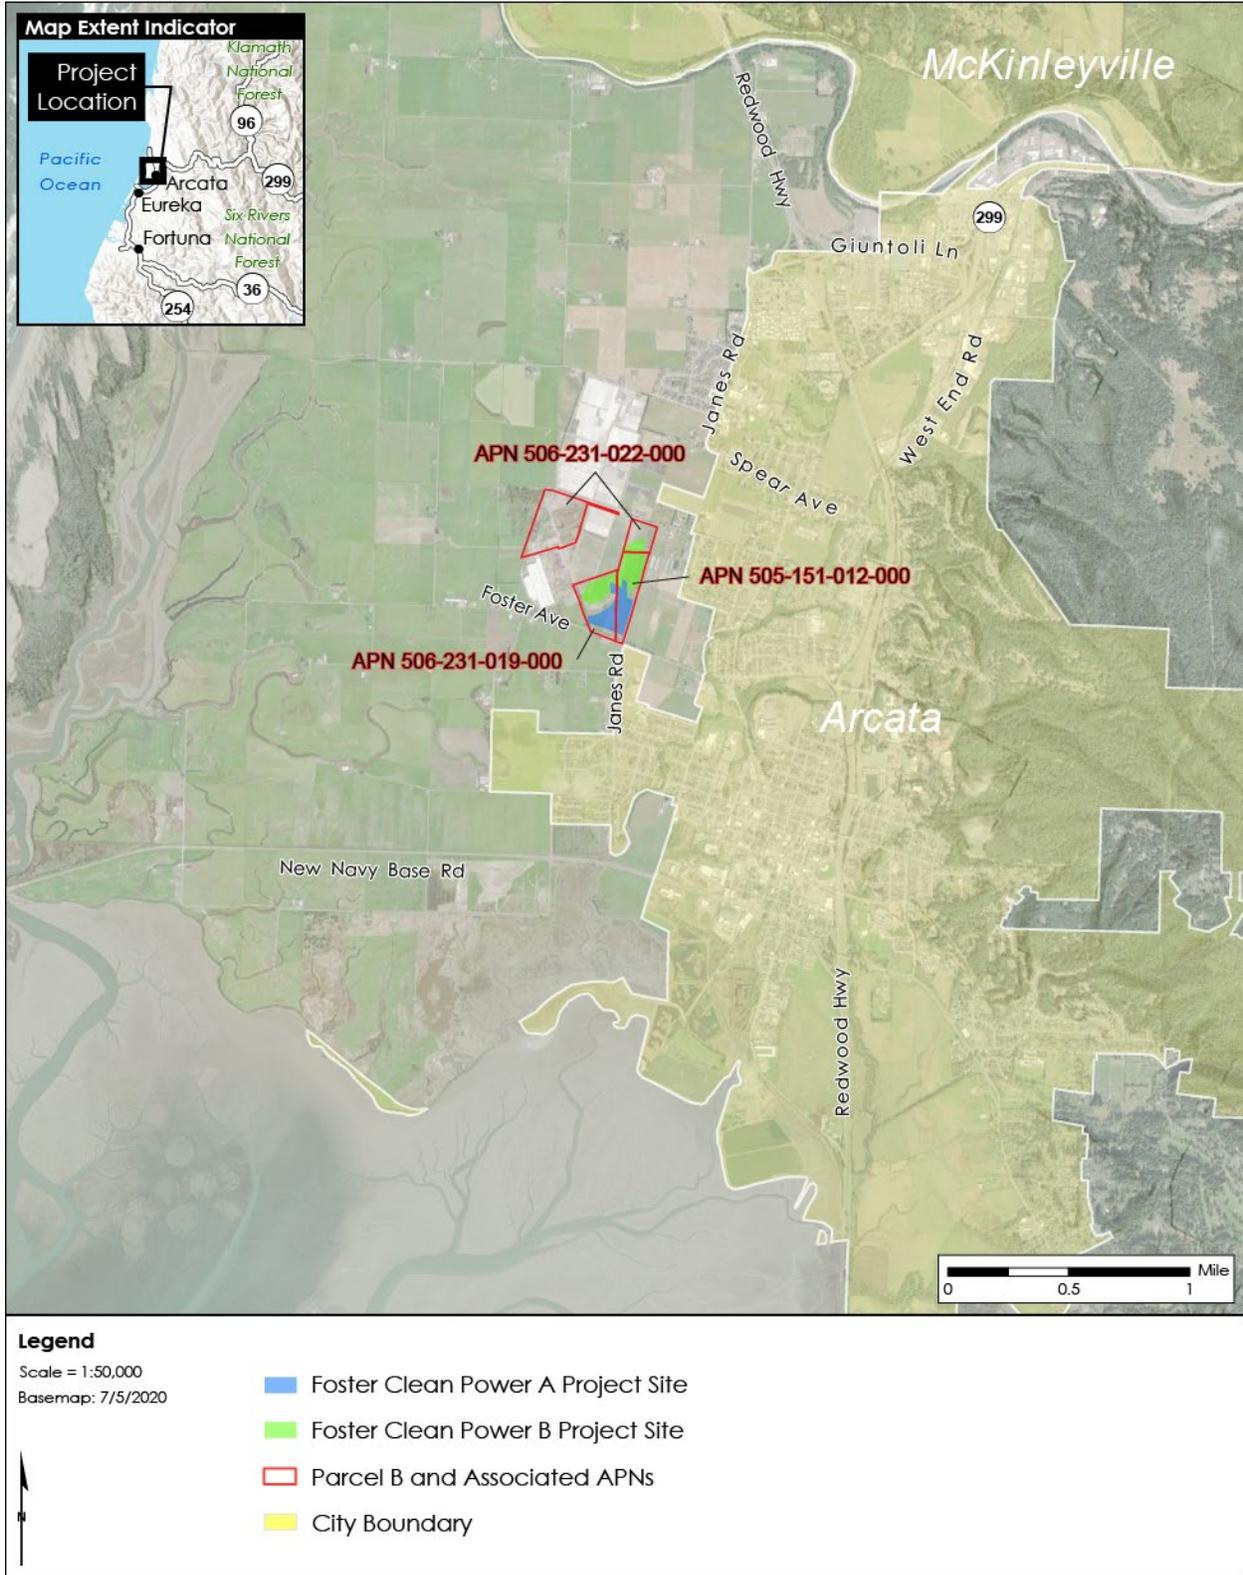


Appendix A Figures


APPENDIX A

Figure A-1 Foster Clean Power Project Location




APPENDIX A

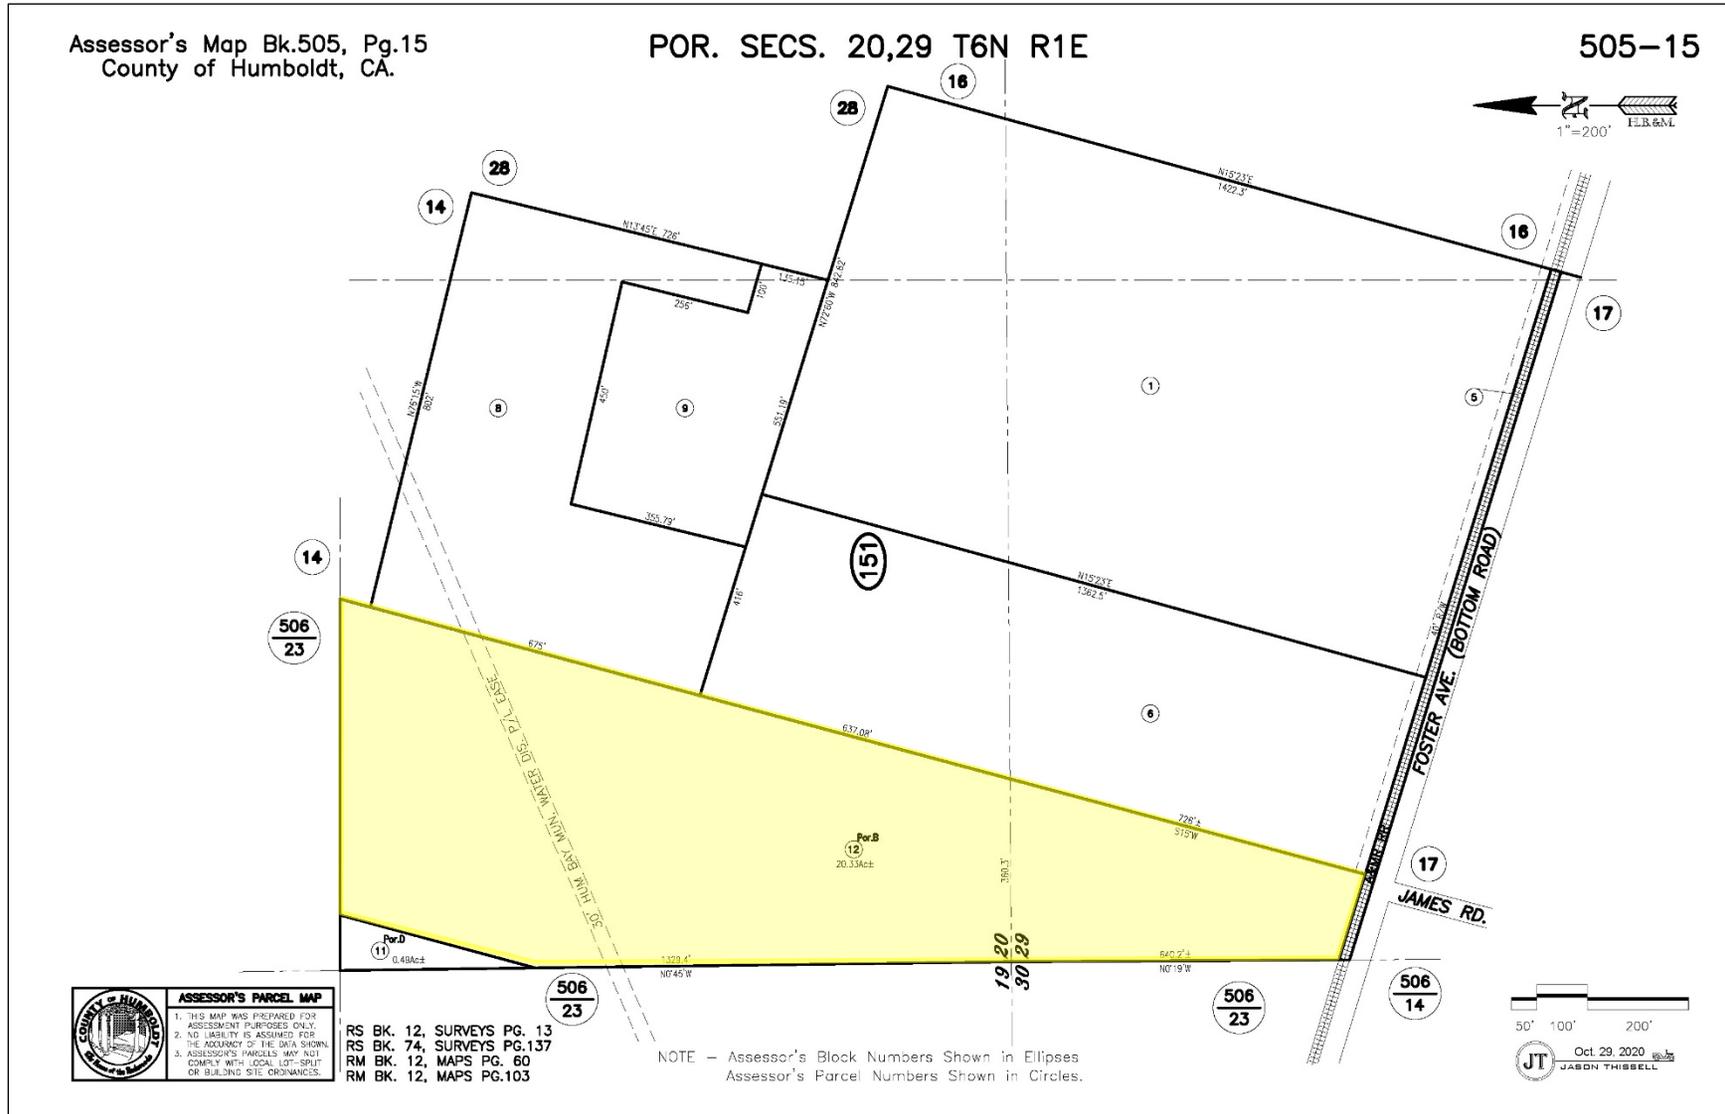Figure A-2 Assessor's Parcel Map 505-15




APPENDIX A

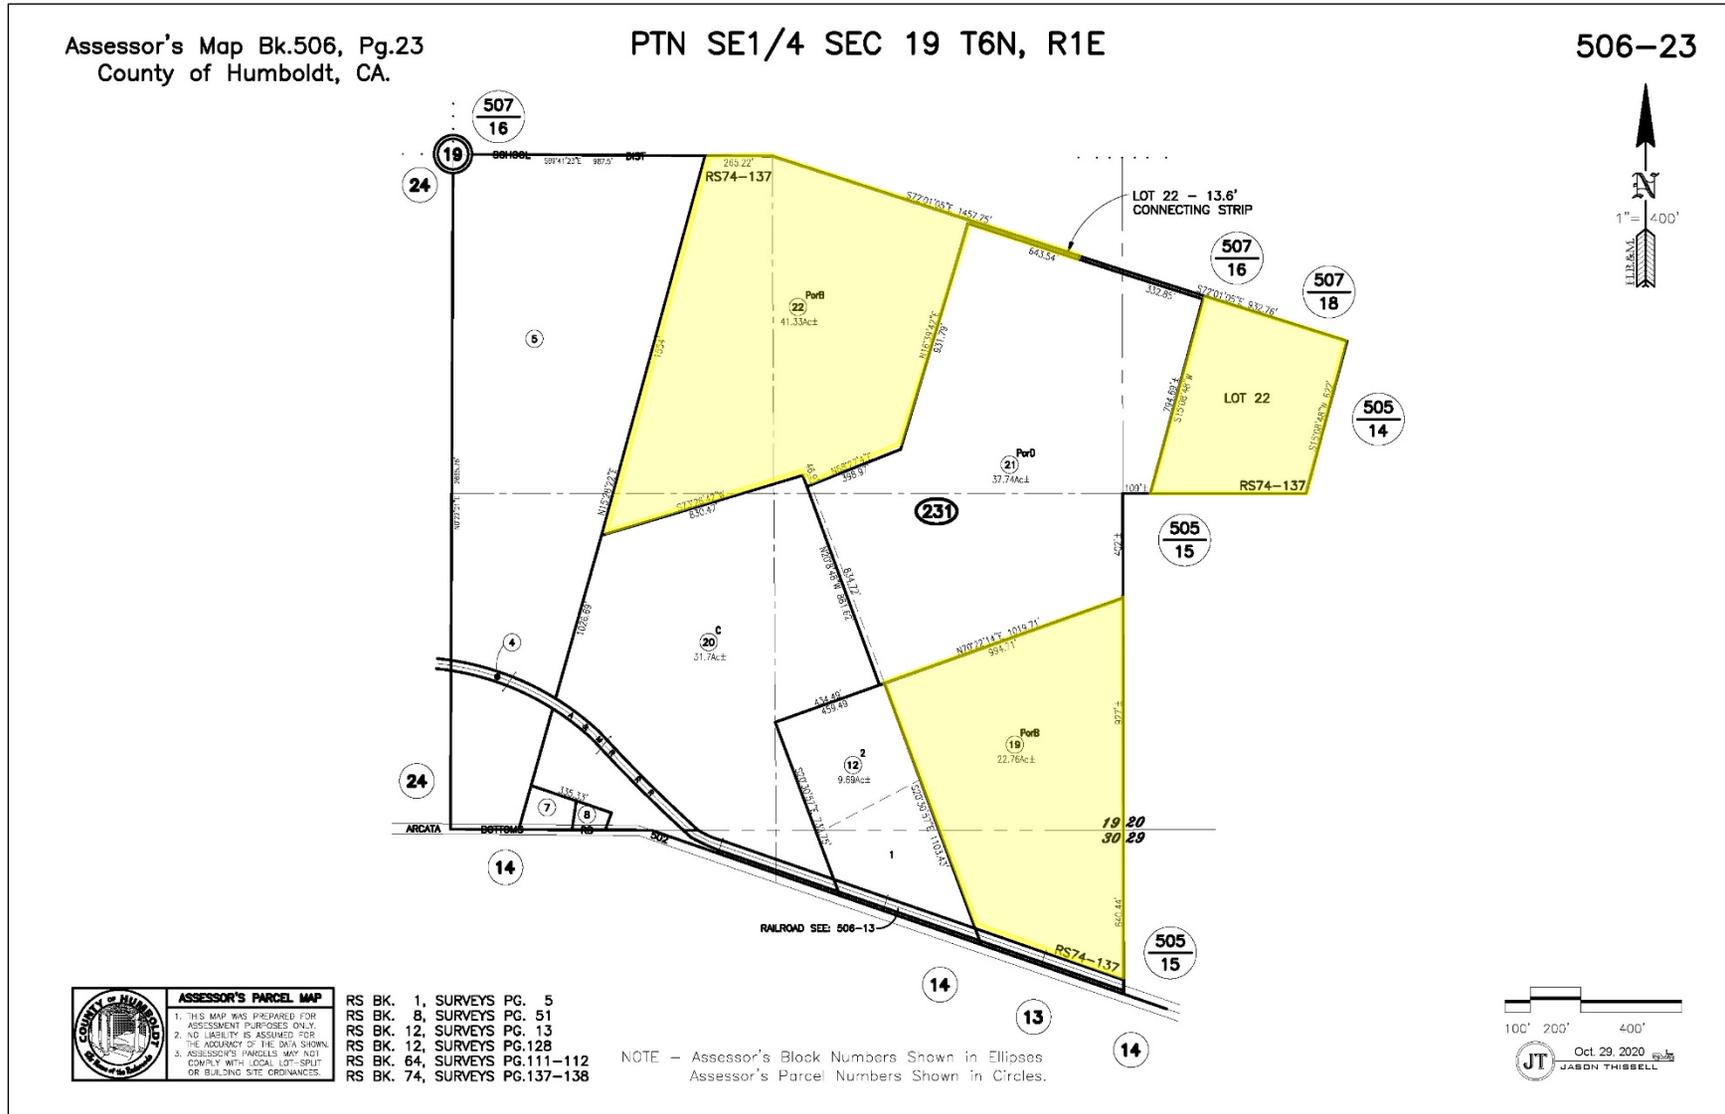Figure A-3 Assessor's Parcel Map 506-23



APPENDIX A

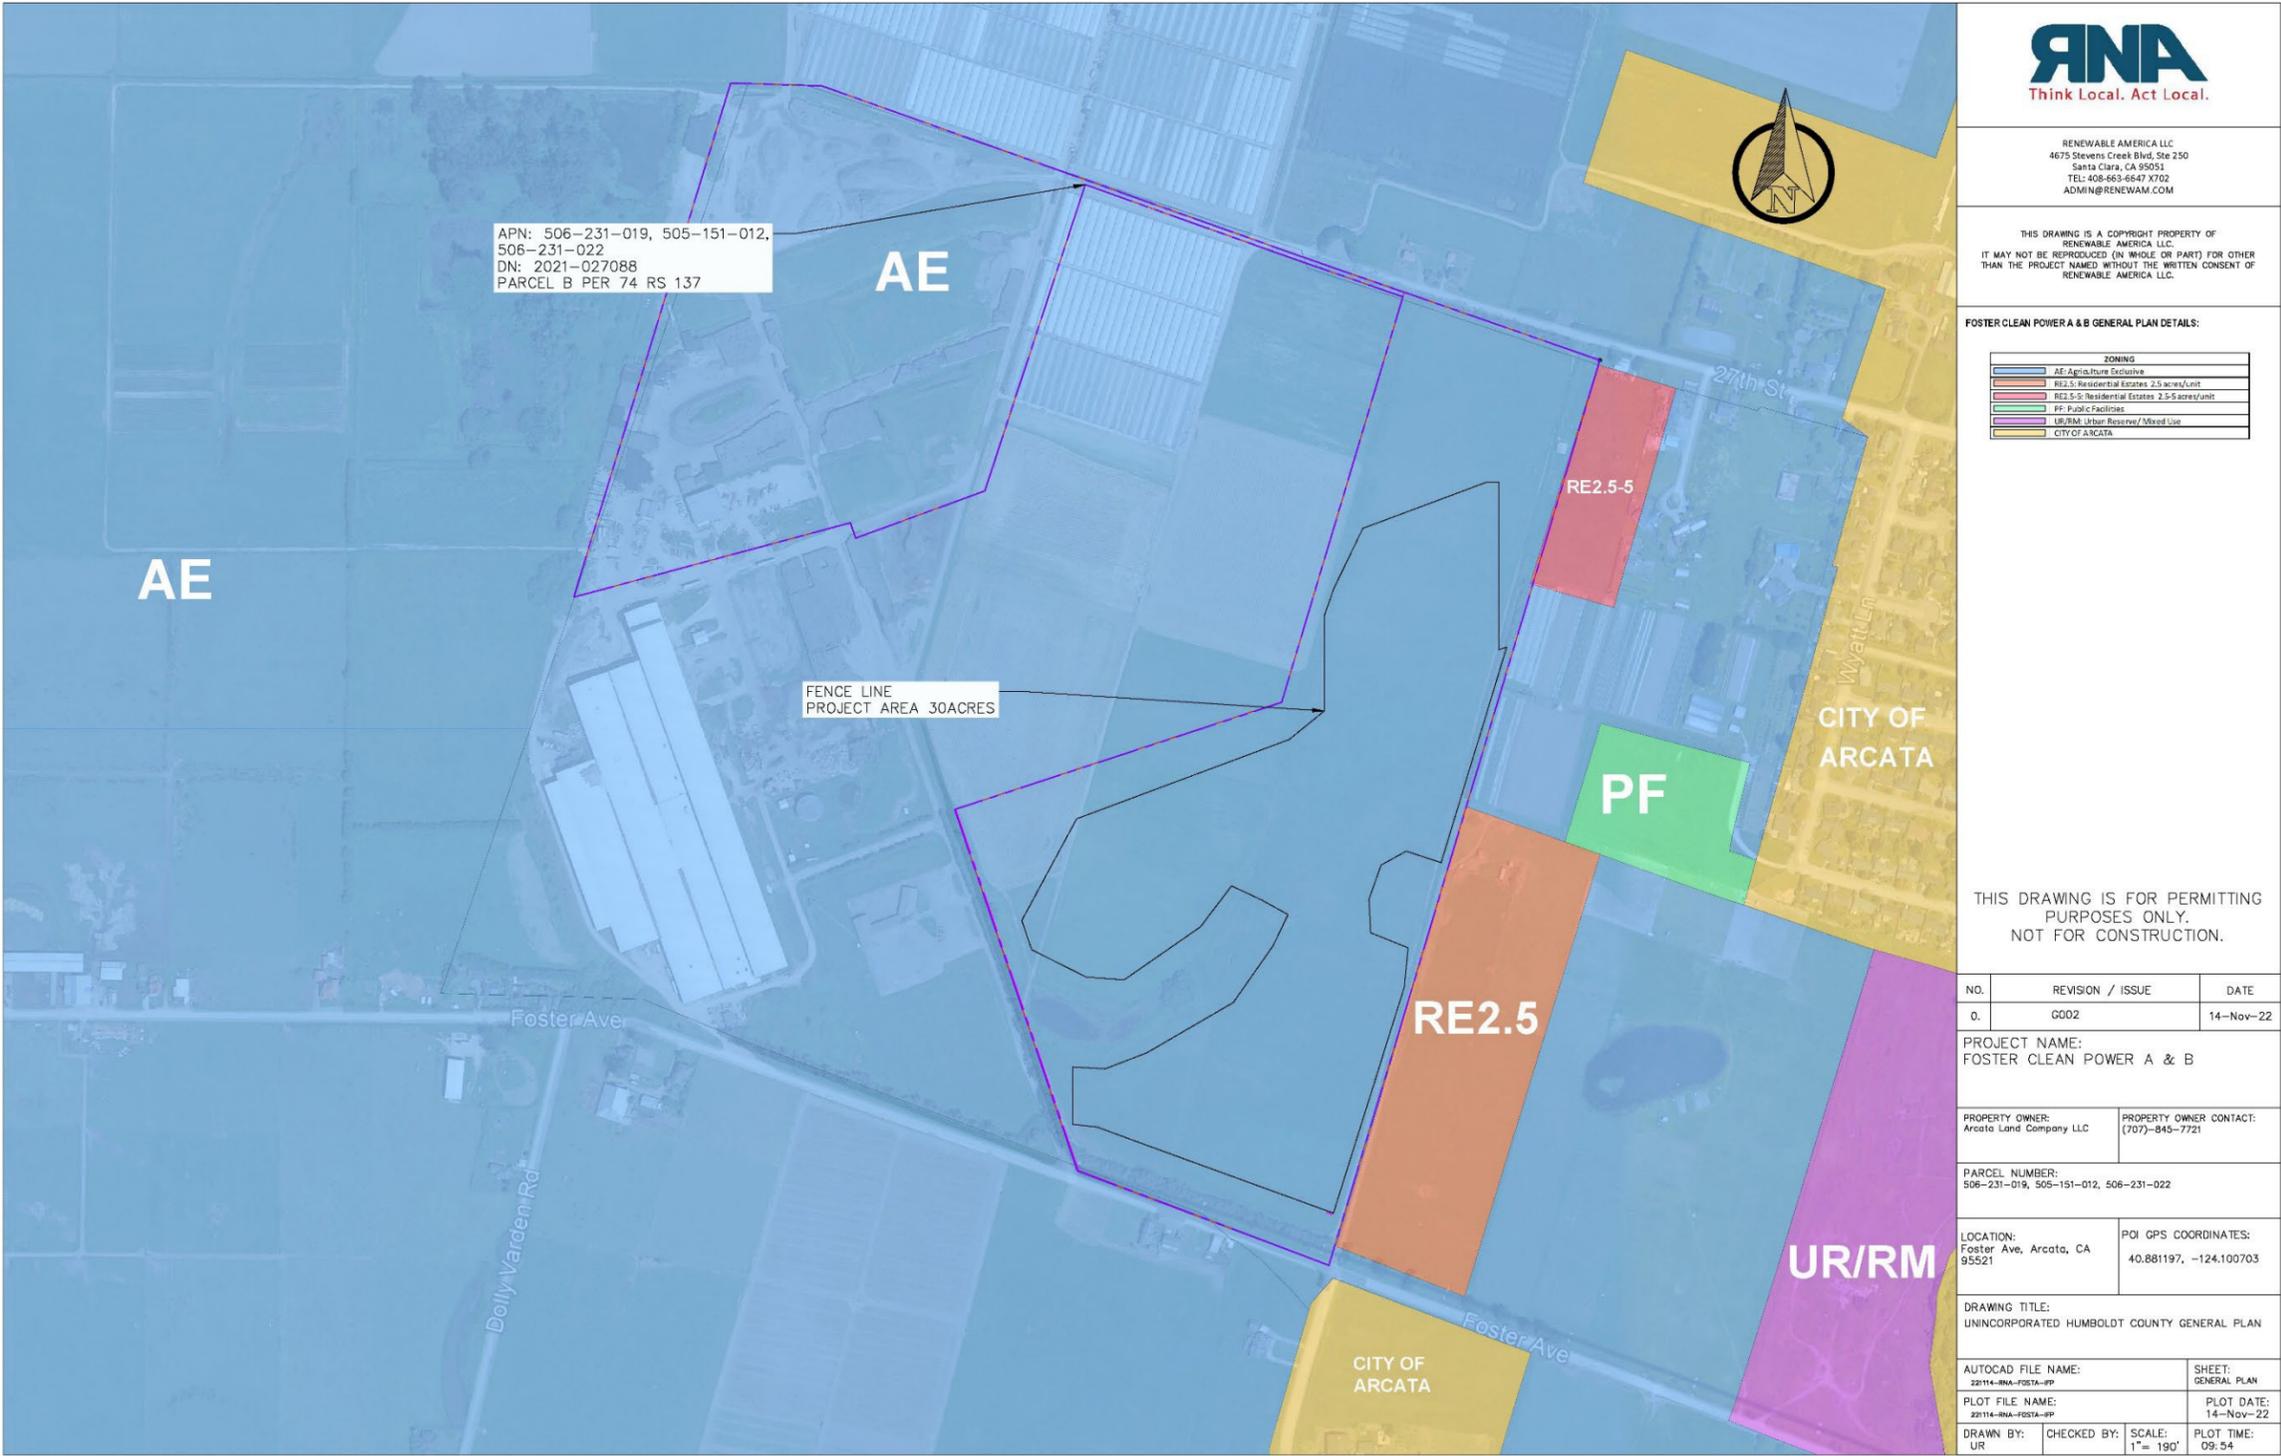Figure A-4 Humboldt County General Plan Land Use Designations



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FOSTER CLEAN POWER A & B GENERAL PLAN DETAILS:

ZONING	
[Blue Box]	AE: Agriculture Exclusive
[Red Box]	RE2.5: Residential Estates 2.5 acres/unit
[Orange Box]	RE2.5-5: Residential Estates 2.5-5 acres/unit
[Green Box]	PF: Public Facilities
[Purple Box]	UR/RM: Urban Reserve/Mixed Use
[Yellow Box]	CITY OF ARCATA

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NO.	REVISION / ISSUE	DATE
0.	G002	14-Nov-22

PROJECT NAME:
FOSTER CLEAN POWER A & B

PROPERTY OWNER:
Arcata Land Company LLC

PROPERTY OWNER CONTACT:
(707)-845-7721

PARCEL NUMBER:
506-231-019, 505-151-012, 506-231-022

LOCATION:
Foster Ave, Arcata, CA 95521


POI GPS COORDINATES:
40.881197, -124.100703

DRAWING TITLE:
UNINCORPORATED HUMBOLDT COUNTY GENERAL PLAN

AUTOCAD FILE NAME: 22114-RNA-FOSTA-IP	SHEET: GENERAL PLAN
PLOT FILE NAME: 22114-RNA-FOSTA-IP	PLOT DATE: 14-Nov-22
DRAWN BY: UR	CHECKED BY: UR
SCALE: 1" = 190'	PLOT TIME: 09:54

APPENDIX A

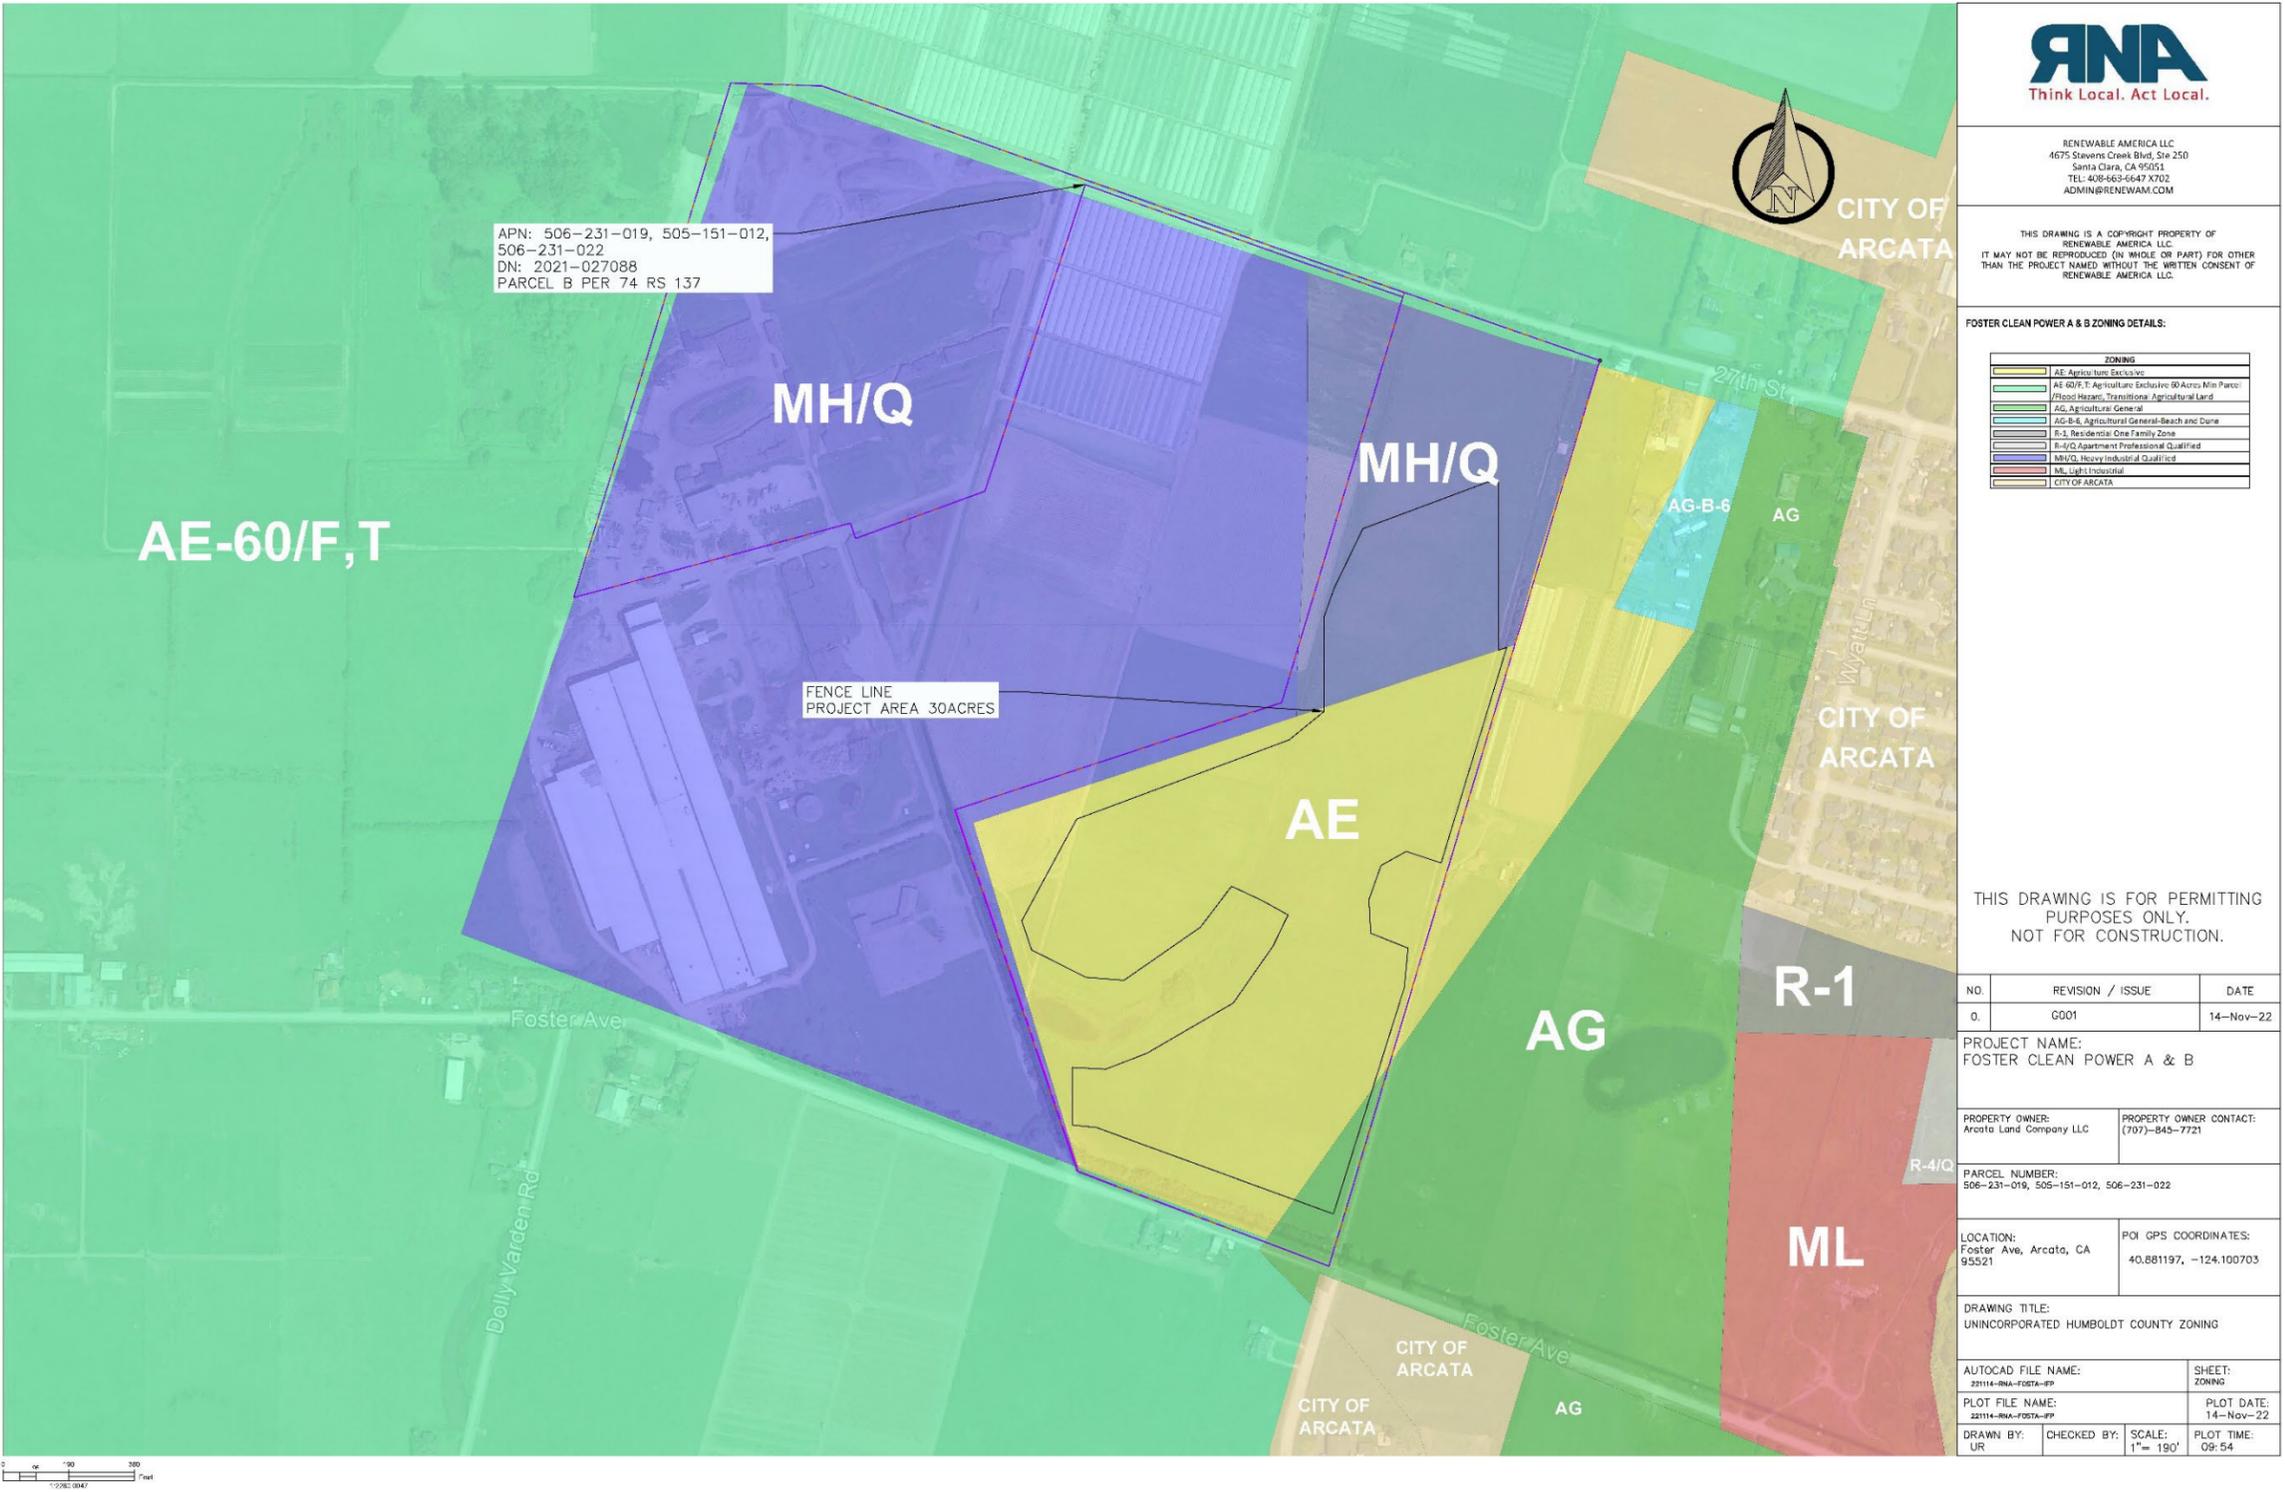Figure A-5 Humboldt County Zoning Ordinance



APPENDIX A

Figure A-7 Foster Clean Power B Project Site Plan




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FOSTER CLEAN POWER B PV SYSTEM SPECS:

MODULE SPECIFICATION	
MODULE TYPE	6700
PV MODULE MODEL	CHR600A-HC
PV MODULE POWER (Watt)	390
OPEN CIRCUIT VOLTAGE (V)	40.28
VOLTAJE TEMP. COEFF. (%/C)	-0.25
INVERTER SPECIFICATION	
INVERTER TYPE	POWER ELECTRONICS
MAX DC INPUT VOLTAGE (V)	1500
MAX DC INPUT CURRENT (A)	25
MAX AC OUTPUT VOLTAGE (V)	240
MAX AC OUTPUT CURRENT (A)	100
PV SYSTEM SPECIFICATION	
TOTAL NUMBER OF MODULES	4000
TOTAL NUMBER OF INVERTERS	1000
AC SYSTEM VOLTAGE (V)	240
TOTAL NUMBER OF INVERTERS	1
INVERTER RATIO	3.96
INVERTER SPACING (FT)	11.3
1C 3.5 STRING TRACKER QUANTITY	24
1C 2.5 STRING TRACKER QUANTITY	72
INVERTER ANGULAR RANGE (°)	30
BATTERY STORAGE SYSTEM SPECIFICATION	
MAX BATTERY STORAGE CAPACITY (KWH)	0
MAX DC INPUT CURRENT (A)	100
MAXIMUM VOLTAGE (V)	250
MAX AC OUTPUT CURRENT (A)	100
MAX AC OUTPUT VOLTAGE (V)	240
AC SYSTEM VOLTAGE (V)	240
MAX AC OUTPUT CURRENT (A)	100
TOTAL BATTERY STORAGE CAPACITY (KWH)	0
TOTAL BATTERY STORAGE CAPACITY (KWH)	0



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NO.	REVISION / ISSUE	DATE
0.	A002	14-Nov-22

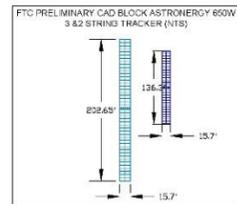PROJECT NAME:
FOSTER CLEAN POWER A & B

PROPERTY OWNER:
Arcata Land Company LLC

PROPERTY OWNER CONTACT:
(707)-845-7721

PARCEL NUMBER:
506-231-019, 505-131-012, 506-231-022

LOCATION:
Foster Ave, Arcata, CA
95521


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40.881197, -124.100703

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SCALE: 1"= 190'	PLOT TIME: 09:54

APPENDIX A

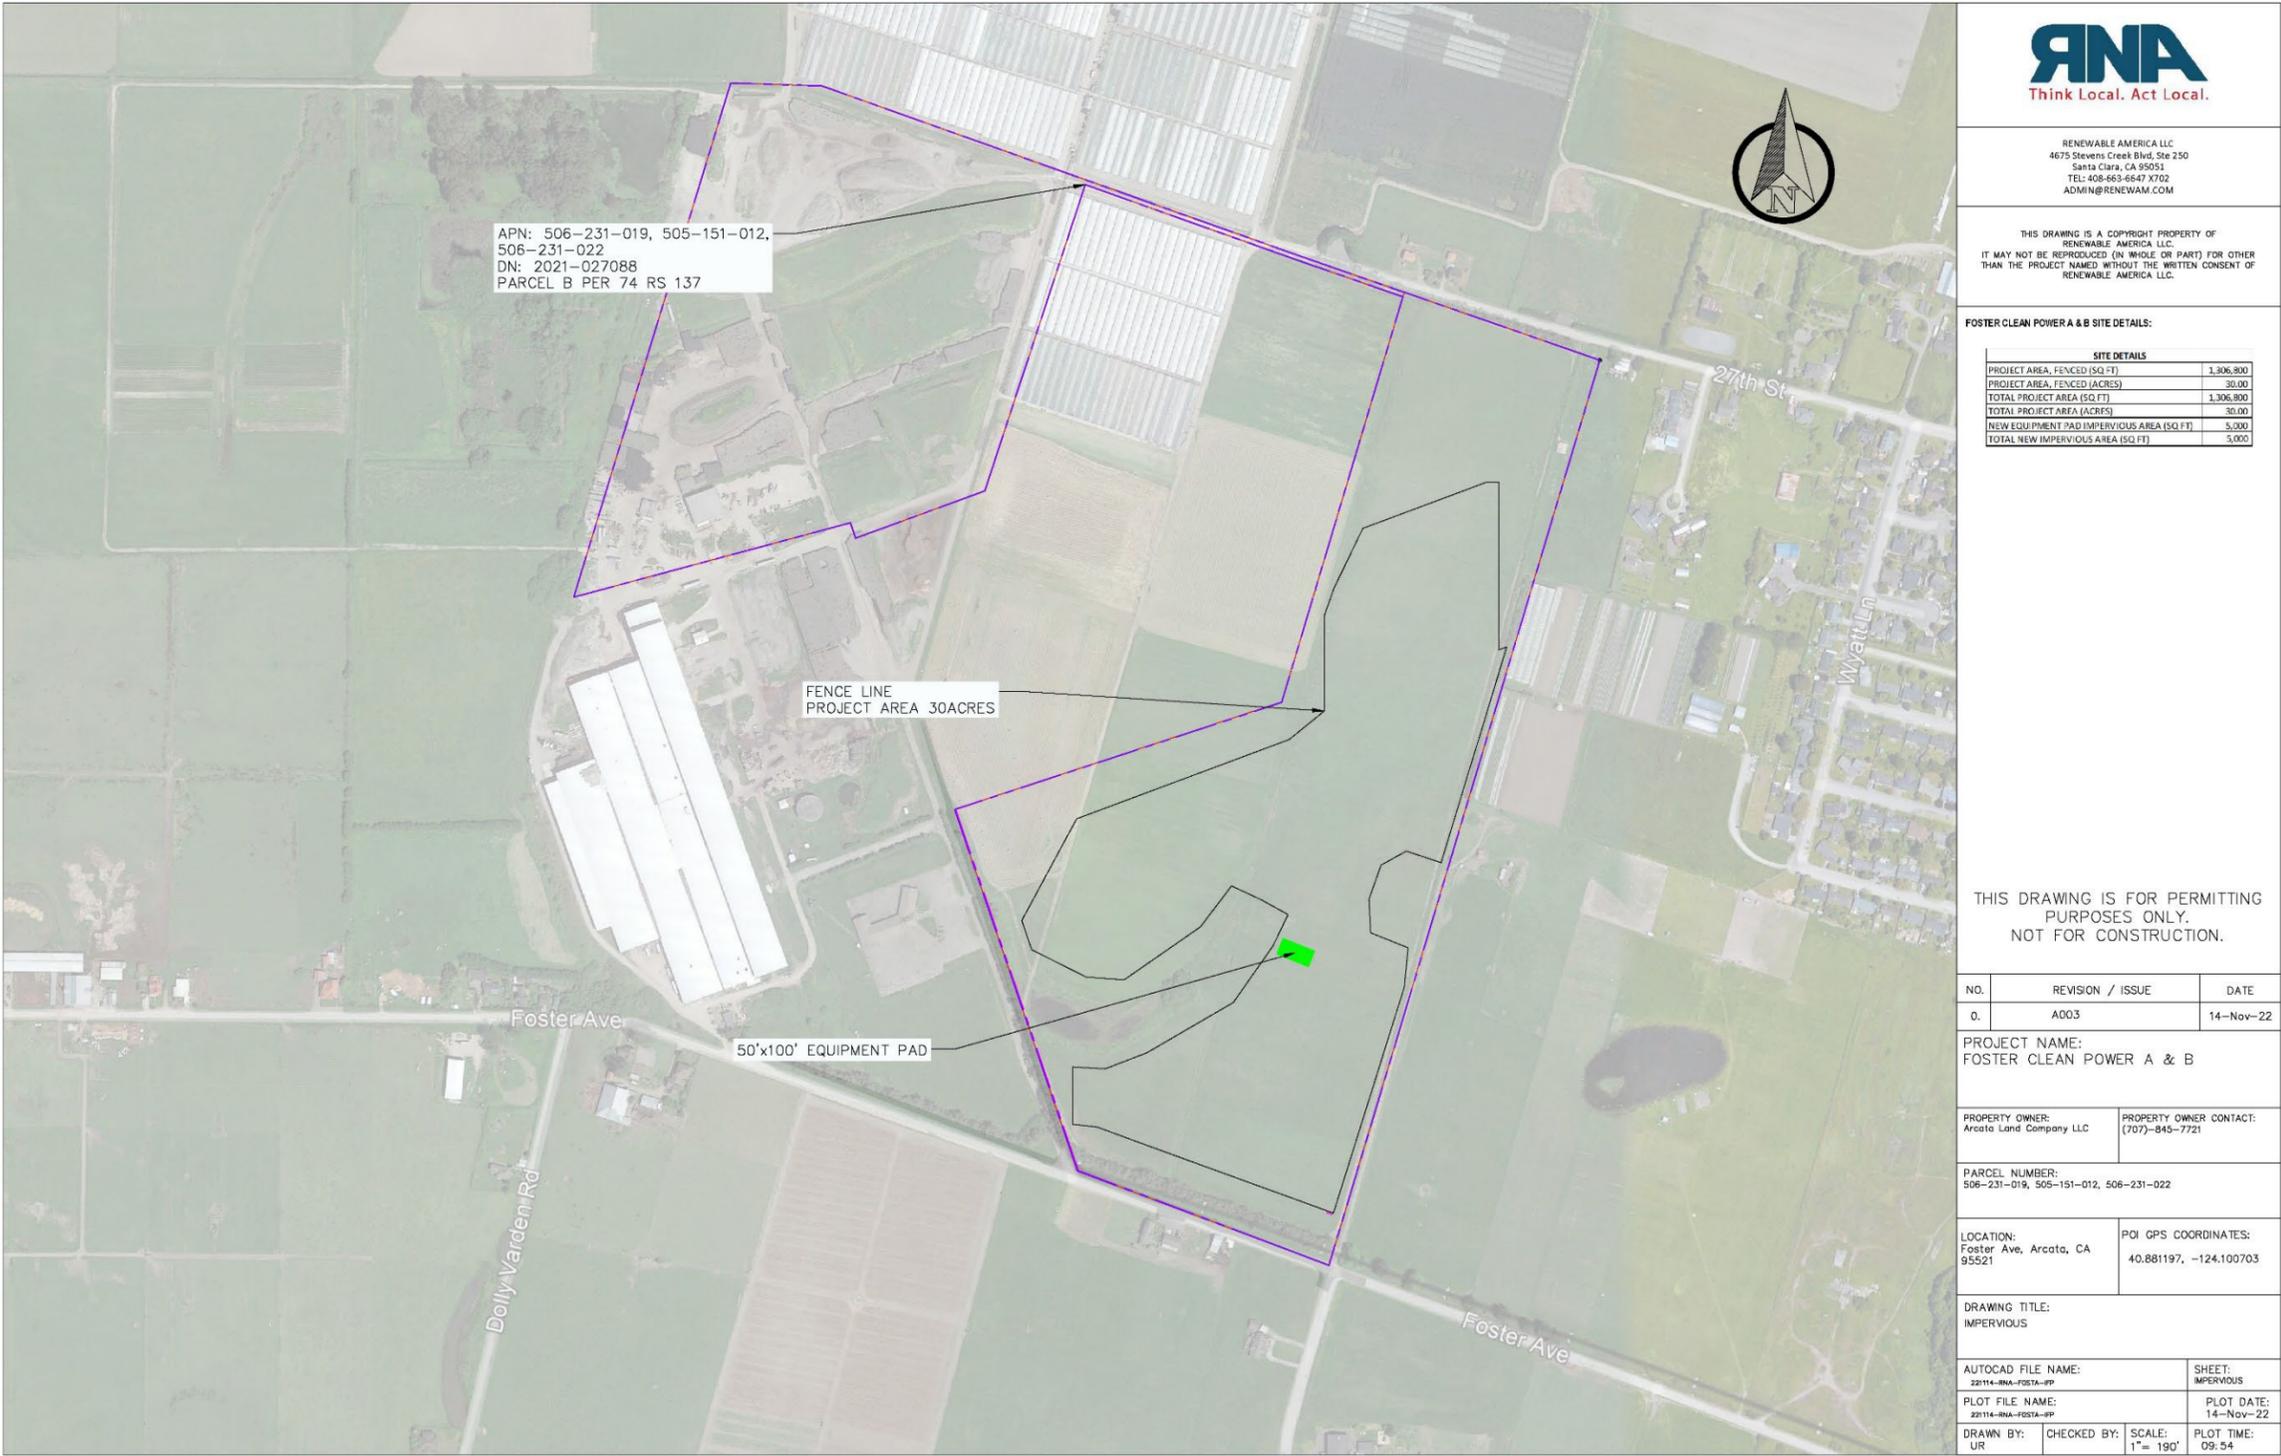Figure A-8 Impervious Surface



APPENDIX A



Figure A-9 Foster Clean Power A Single Line Diagram

EQUIPMENT NOTES:

- A. NOT USED .
- B. 3000A, 630V, 3P, 65KAIC, EATON MAGNUM DS CIRCUIT BREAKER. AS PV SYSTEM LOCKABLE DISCONNECT
- C. NOT USED.
- D. INV-1: 3000KW, 690V-AC, 2756A, 3φ, 3W CENTRAL HYBRID INVERTER TYPE, POWER ELECTRONICS FS3290K (1500V-DC MAX INPUT VOLTAGE), UL1741-SA CERTIFIED INVERTER MAX. OUTPUT POWER SHALL BE ELECTRONICALLY CURTAILED TO 3000KW-AC BY MANUFACTURER.
- E. (6,840) X MODULES: 650W, 1500V-DC, UL LISTED SOLAR PV MODULE, TYPE ASTROENERGY CHSM66M-HC.
- F. NOT USED.
- G. NOT USED.
- H. (2) X ENERGY STORAGE SYSTEM (ESS), DC-COUPLED, BYD CP32-B2800-U-R4M02/WVR , UL9540 CERTIFIED, 2610 KWH, 625KW, 1094.4V-DC.

KEY NOTES:

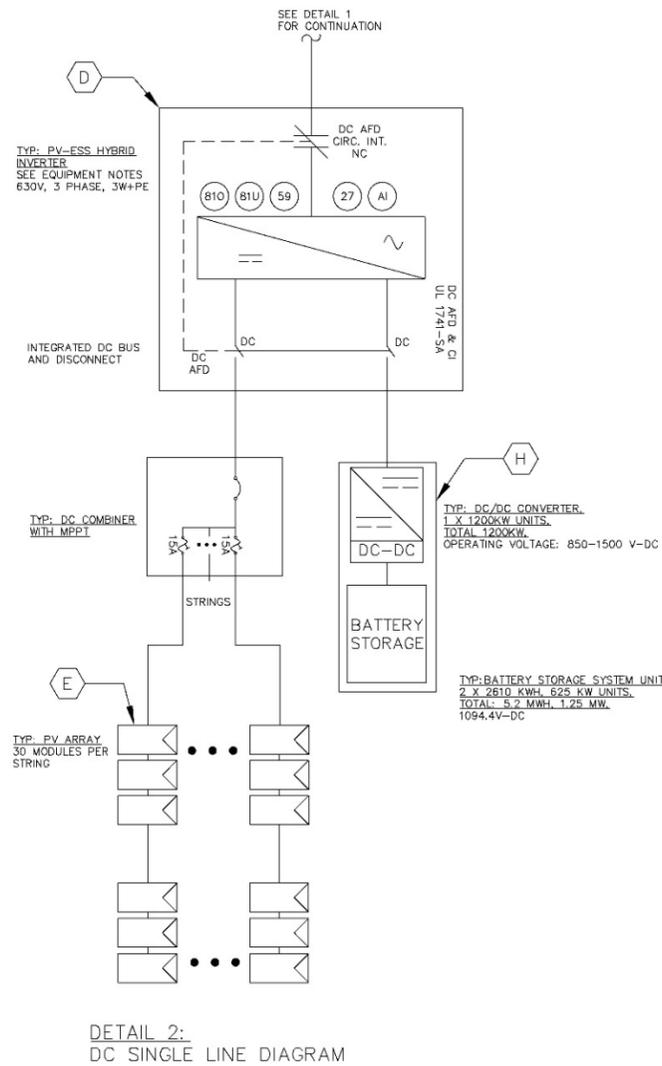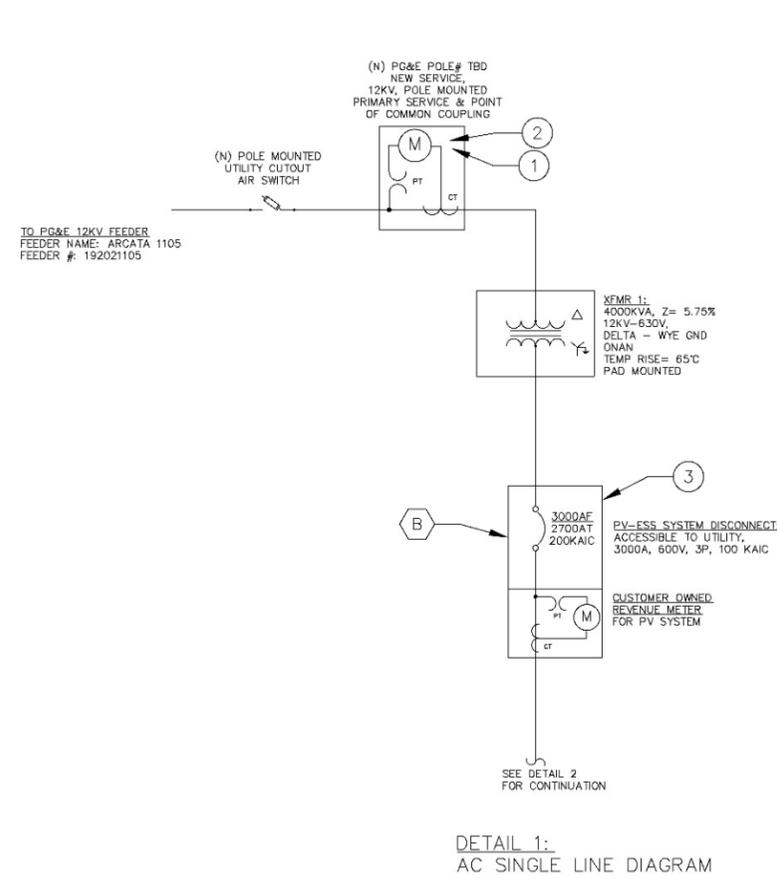1. NEW SERVICE AND METERING SYSTEM (BY UTILITY).
2. POINT OF COMMON COUPLING (PCC). SYMMETRICAL FAULT CURRENT FROM PV SYSTEM AT PCC = 249.7A @ 12000V.
3. PROVIDE ACCESSIBLE LOCKABLE DISCONNECT AND PROTECTION DEVICE PER UTILITY INTERCONNECTION GUIDELINES TO ISOLATE GENERATING FACILITY FROM UTILITY DISTRIBUTION SYSTEM.
4. SYMMETRICAL FAULT CURRENT FROM PV SYSTEM AT PV SYSTEM DISCONNECT = 3,745A @ 630V.



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FOSTER CLEAN POWER A PV SYSTEM SPECS:

MODULE SPECIFICATION	
MANUFACTURER	ASTRO
PV MODULE MODEL	CHSM66M-HC
PV MODULE POWER (Pmax)	652
OPEN CIRCUIT VOLTAGE (Voc)	45.38
VOLTAGE TEMP. COEFF. (Voc)	-0.37
INVERTER SPECIFICATION	
MANUFACTURER	POWER ELECTRONICS CO
INVERTER MODEL	FS3290K
MAX OUTPUT POWER (KW)	3000
AC OUTPUT CURRENT (A)	2756
NOM AC VOLTAGE (V)	600V
MAX INPUT CURRENT (A)	865
MIN VOLTAGE STARTUP (V)	600
MAX INPUT VOLTAGE (V)	1500V
PV SYSTEM SPECIFICATION	
DC VOLTAGE (V)	850V
TOTAL NUMBER OF MODULES	6840
DC SYSTEM WATTAGE (KW)	3000
TOTAL NUMBER OF INVERTERS	1
WIRING RATIO	1.88
INVERTER TRACKING	
PTC 2 STRING TRACKER QUANTITY	36
PTC 4 STRING TRACKER QUANTITY	60
TURBING RATIO	0.0
BATTERY STORAGE SYSTEM SPECIFICATION	
MANUFACTURER	BYD
ESS MODEL	CP32-B2800-U-R4M02/WVR
MAX DC OUTPUT CURRENT (A)	625
NOM AC VOLTAGE (V)	1094.4
BATTERY CAPACITY (KWH)	2610
OUTPUT POWER (KW)	625
DC-COUPLED INVERTER PFC	2000
TOTAL BATTERY QUANTITY	2
TOTAL BATTERY (KWH)	5.2
TOTAL BATTERY CAPACITY (KWH)	5.2

NOTE: ELECTRICAL SINGLE LINE DIAGRAM IS NOT FOR CONSTRUCTION AND WILL BE UPDATED PRIOR TO CONSTRUCTION START

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NO.	REVISION / ISSUE	DATE
0.	E001	14-Nov-22

PROJECT NAME:
FOSTER CLEAN POWER A & B

PROPERTY OWNER: Arcata Land Company LLC	PROPERTY OWNER CONTACT: (707)-845-7721
--	---

PARCEL NUMBER:
506-231-019, 505-151-012, 506-231-022

LOCATION: Foster Ave, Arcata, CA 95521	POI GPS COORDINATES: 40.881197, -124.100703
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DRAWING TITLE:
ELECTRICAL SINGLE LINE DIAGRAM

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APPENDIX A



Figure A-10 Foster Clean Power B Single Line Diagram

EQUIPMENT NOTES:

- A. NOT USED .
- B. 3000A, 630V, 3P, 65KAIC, EATON MAGNUM DS CIRCUIT BREAKER. AS PV SYSTEM LOCKABLE DISCONNECT
- C. NOT USED.
- D. INV-1: 4000KW, 690V-AC, 3674A, 3φ, 3W CENTRAL HYBRID INVERTER TYPE, POWER ELECTRONICS FS4390K (1500V-DC MAX INPUT VOLTAGE), UL1741-SA CERTIFIED INVERTER MAX. OUTPUT POWER SHALL BE ELECTRONICALLY CURTAILED TO 4000KW-AC BY MANUFACTURER.
- E. (9,120) X MODULES: 650W, 1500V-DC, UL LISTED SOLAR PV MODULE, TYPE ASTROENERGY CHSM66M-HC.
- F. NOT USED.
- G. NOT USED.
- (6) X ENERGY STORAGE SYSTEM (ESS), DC-COUPLED, BYD CP32-B2800-U-R4M02/WVR , UL9540 CERTIFIED, 2610 KWH, 625KW, 1094.4V-DC.

KEY NOTES:

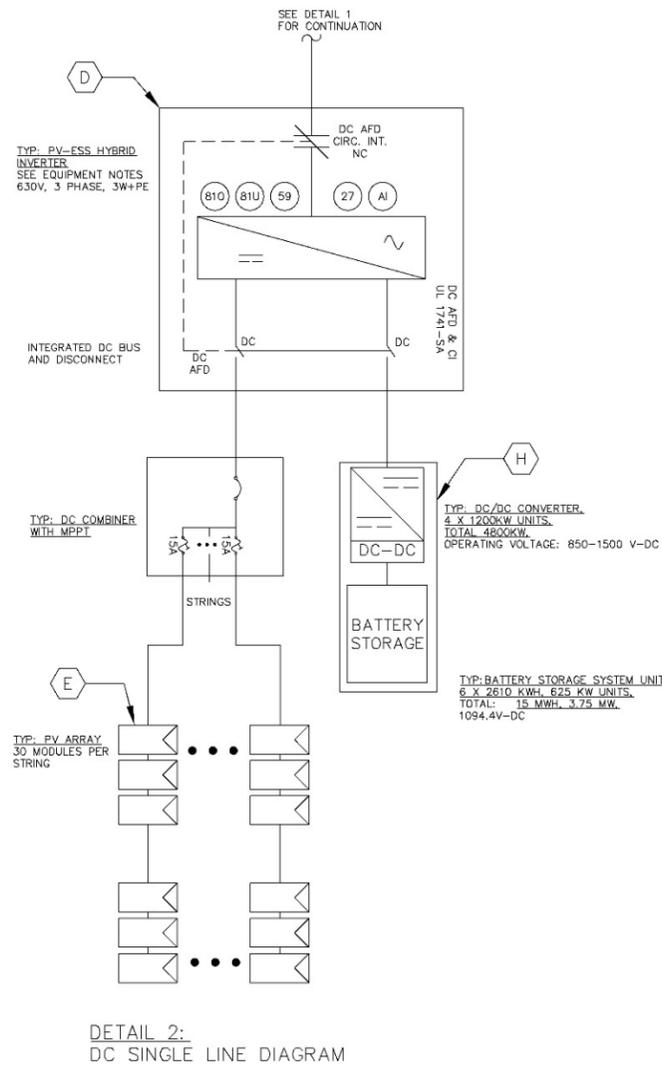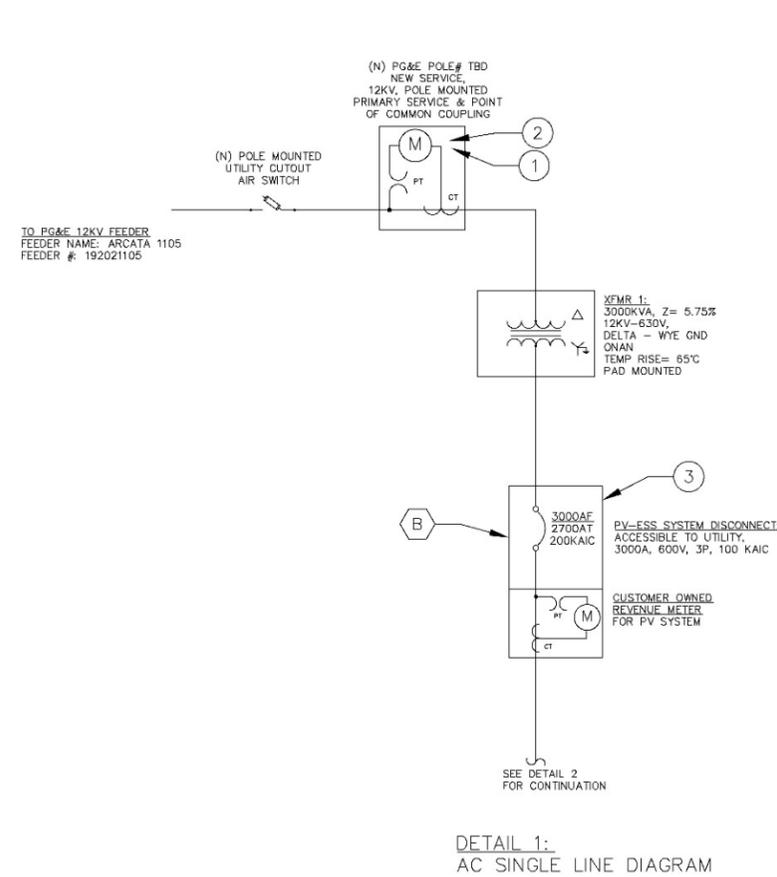1. NEW SERVICE AND METERING SYSTEM (BY UTILITY).
2. POINT OF COMMON COUPLING (PCC). SYMMETRICAL FAULT CURRENT FROM PV SYSTEM AT PCC = 249.7A @ 12000V.
3. PROVIDE ACCESSIBLE LOCKABLE DISCONNECT AND PROTECTION DEVICE PER UTILITY INTERCONNECTION GUIDELINES TO ISOLATE GENERATING FACILITY FROM UTILITY DISTRIBUTION SYSTEM.
4. SYMMETRICAL FAULT CURRENT FROM PV SYSTEM AT PV SYSTEM DISCONNECT = 3,745A @ 630V.



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FOSTER CLEAN POWER B PV SYSTEM SPECS:

MODULE SPECIFICATION	
MANUFACTURER	ASTRO
PV MODULE MODEL	CHSM66M-HC
PV MODULE POWER (Pmax)	650
OPEN CIRCUIT VOLTAGE (Voc)	65.38
VOLTAGE TEMP. COEFF. (INVT)	-0.35
INVERTER SPECIFICATION	
MANUFACTURER	POWER ELECTRONICS
INVERTER MODEL	FS4390K
MAX OUTPUT POWER (kW)	4000
AC OUTPUT CURRENT (A)	3014
MAX AC VOLTAGE (kV)	0.69
MAX INPUT CURRENT (A)	4740
MIN VOLTAGE START UP (V)	276
MAX INPUT VOLTAGE (V)	1500
PV SYSTEM SPECIFICATION	
DC SYSTEM SIZE (kW)	3340
TOTAL NUMBER OF MODULES	9020
# OF VOLTAGE MISMATCH UNITS	4000
TOTAL NUMBER OF INVERTERS	1
LOADING FACTOR	1.36
INVERTER EFFICIENCY	97.1
PTC 3 STRING TRACKER CLAMPTN	43
PTC 2 STRING TRACKER CLAMPTN	76
TUBING ANGLE RANGE (°)	0°
BATTERY STORAGE SYSTEM SPECIFICATION	
MANUFACTURER	BYD
BYD MODEL NO	CP32-B2800-U-R4M02/WVR
MAX DC OUTPUT CURRENT (A)	3014
MAXIMUM VOLTAGE (VDC)	1094.4
BATTERY CAPACITY (kWh)	15000
OUTPUT POWER (kW)	625
DC FRAME VOLTAGE (V)	1094.4
TOTAL BPS (BATT CLAMPTN)	6
10 YEAR BPS POWER RMPER	1.5
TOTAL BPS CAPACITY (kWh)	15000

NOTE: ELECTRICAL SINGLE LINE DIAGRAM IS NOT FOR CONSTRUCTION AND WILL BE UPDATED PRIOR TO CONSTRUCTION START

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NO.	REVISION / ISSUE	DATE
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PROJECT NAME:
FOSTER CLEAN POWER A & B

PROPERTY OWNER:
Arcata Land Company LLC

PROPERTY OWNER CONTACT:
(707)-845-7721

PARCEL NUMBER:
506-231-019, 505-151-012, 506-231-022

LOCATION:
Foster Ave, Arcata, CA 95521

POI GPS COORDINATES:
40.881197, -124.100703

DRAWING TITLE:
ELECTRICAL SINGLE LINE DIAGRAM

AUTOCAD FILE NAME:
221114-RNA-FOSTA-EP

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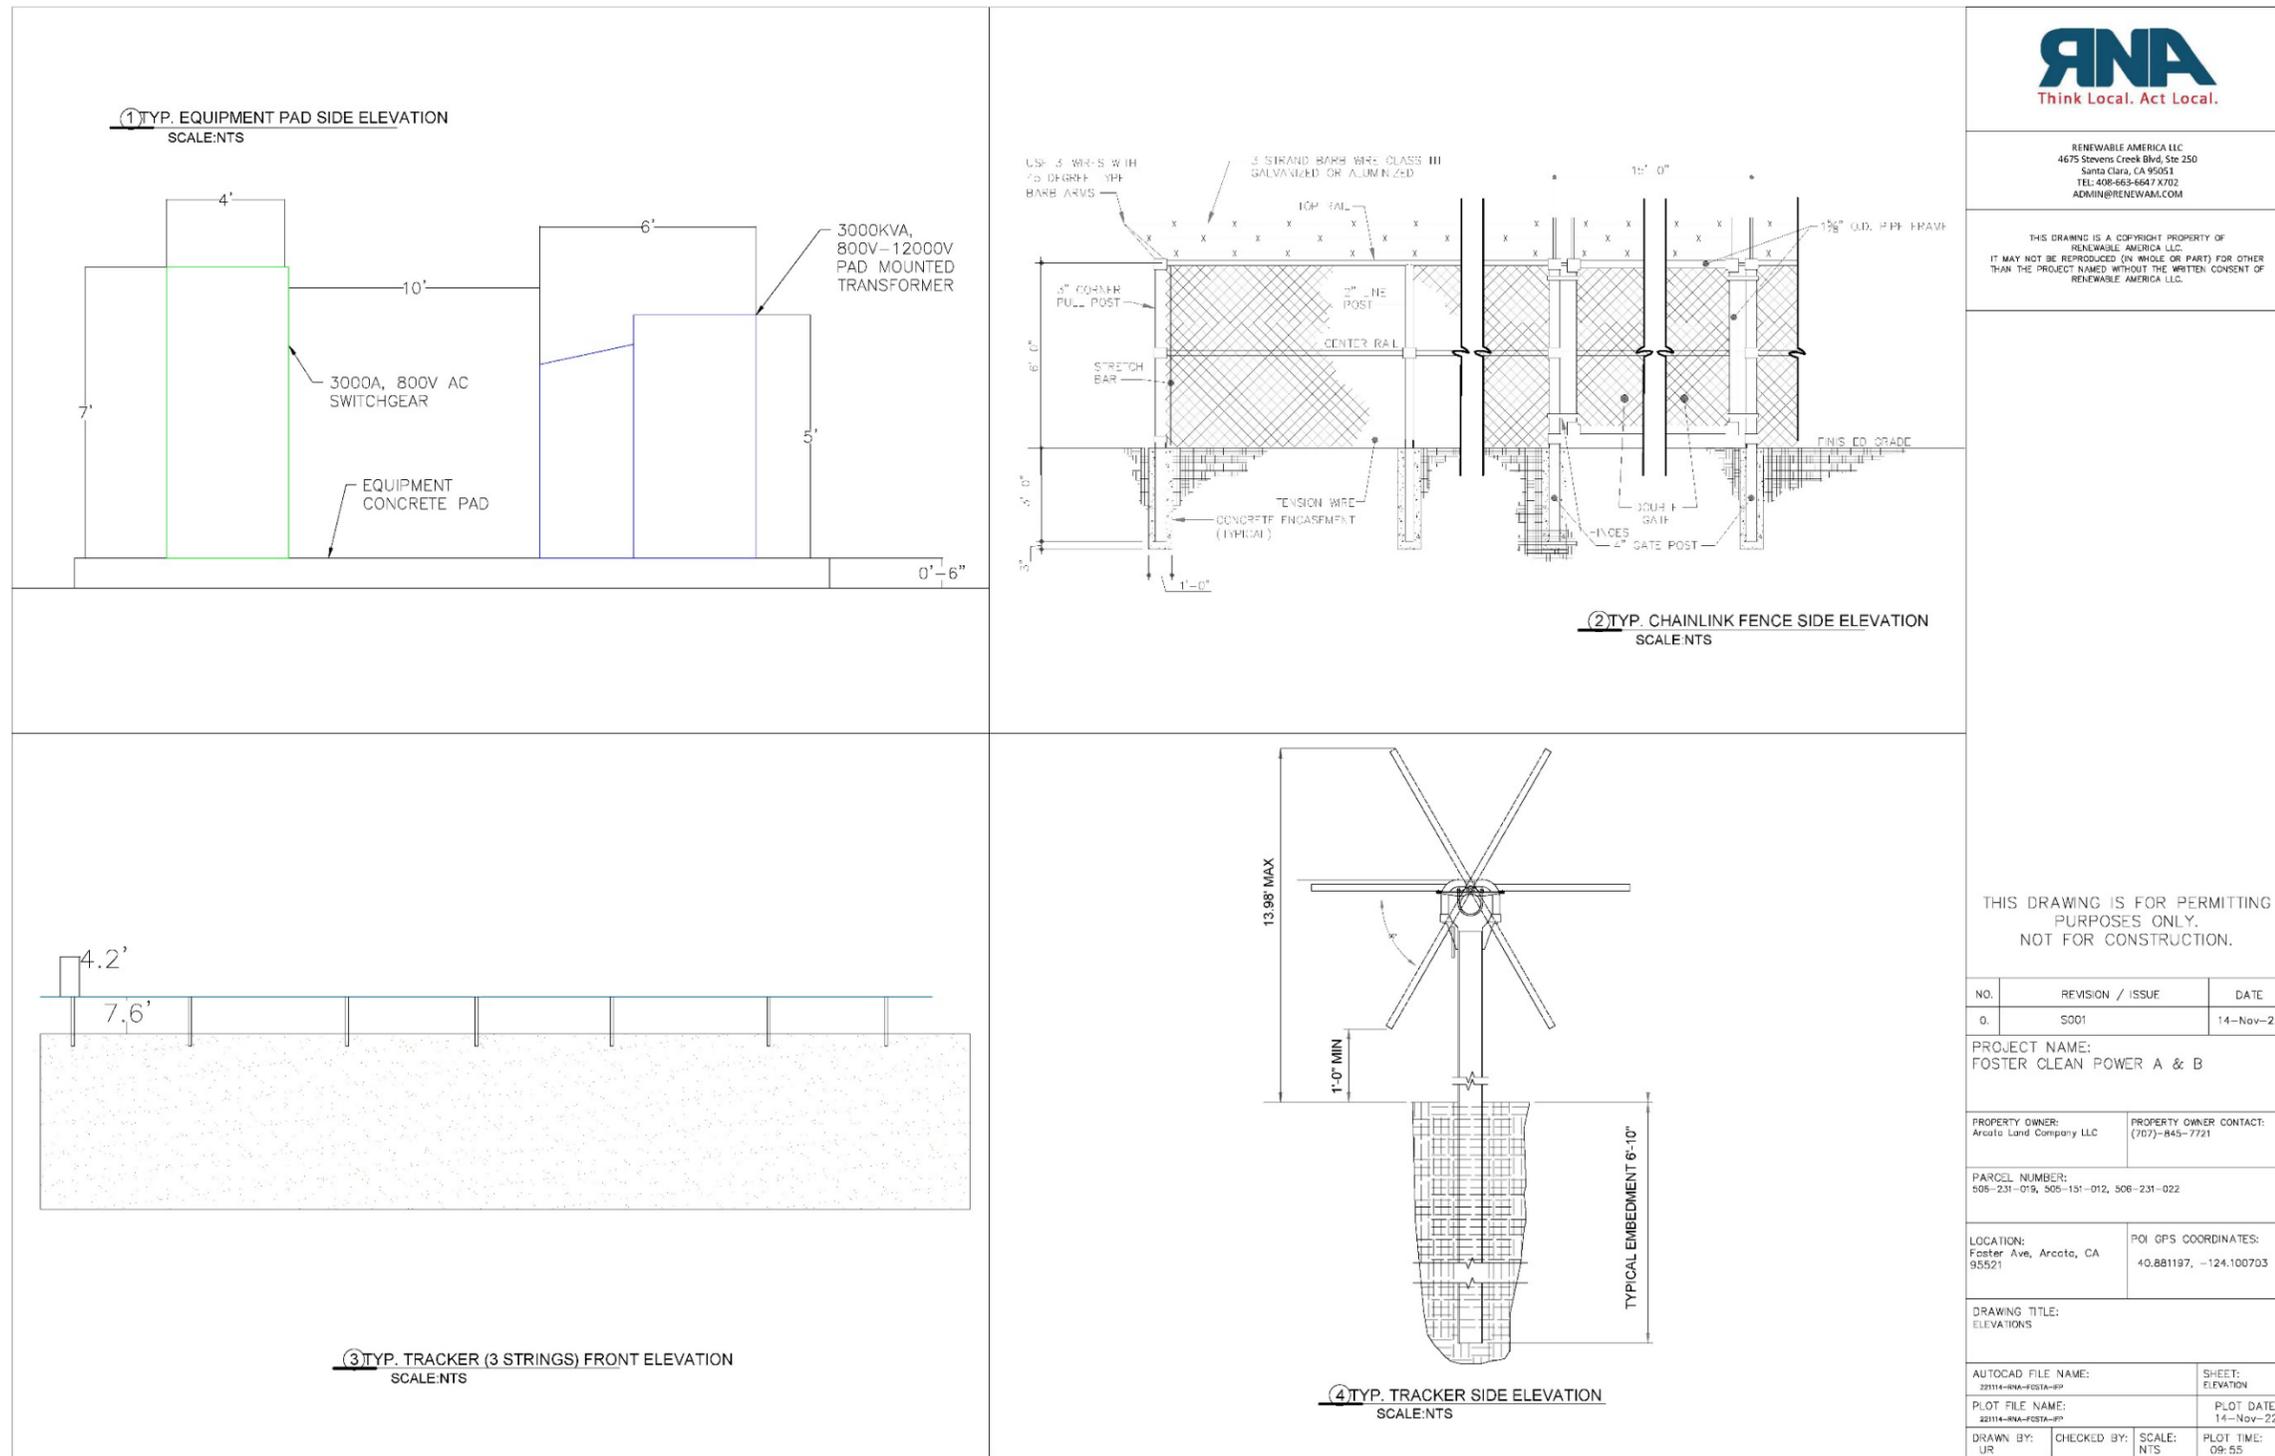
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PLOT TIME:
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APPENDIX A

Figure A-11 Fence, Equipment Pad, and Solar Panel Diagrams



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NO.	REVISION / ISSUE	DATE
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PROJECT NAME:
FOSTER CLEAN POWER A & B

PROPERTY OWNER: Arcata Land Company LLC
PROPERTY OWNER CONTACT: (707)-845-7721

PARCEL NUMBER:
505-231-015, 505-131-012, 506-231-022


LOCATION: Foster Ave, Arcata, CA 95521
POI GPS COORDINATES: 40.881197, -124.100703

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PLOT FILE NAME: 22114-RNA-FOSTA-RP	PLOT DATE: 14-Nov-22
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SCALE: NTS	PLOT TIME: 09:55

APPENDIX A

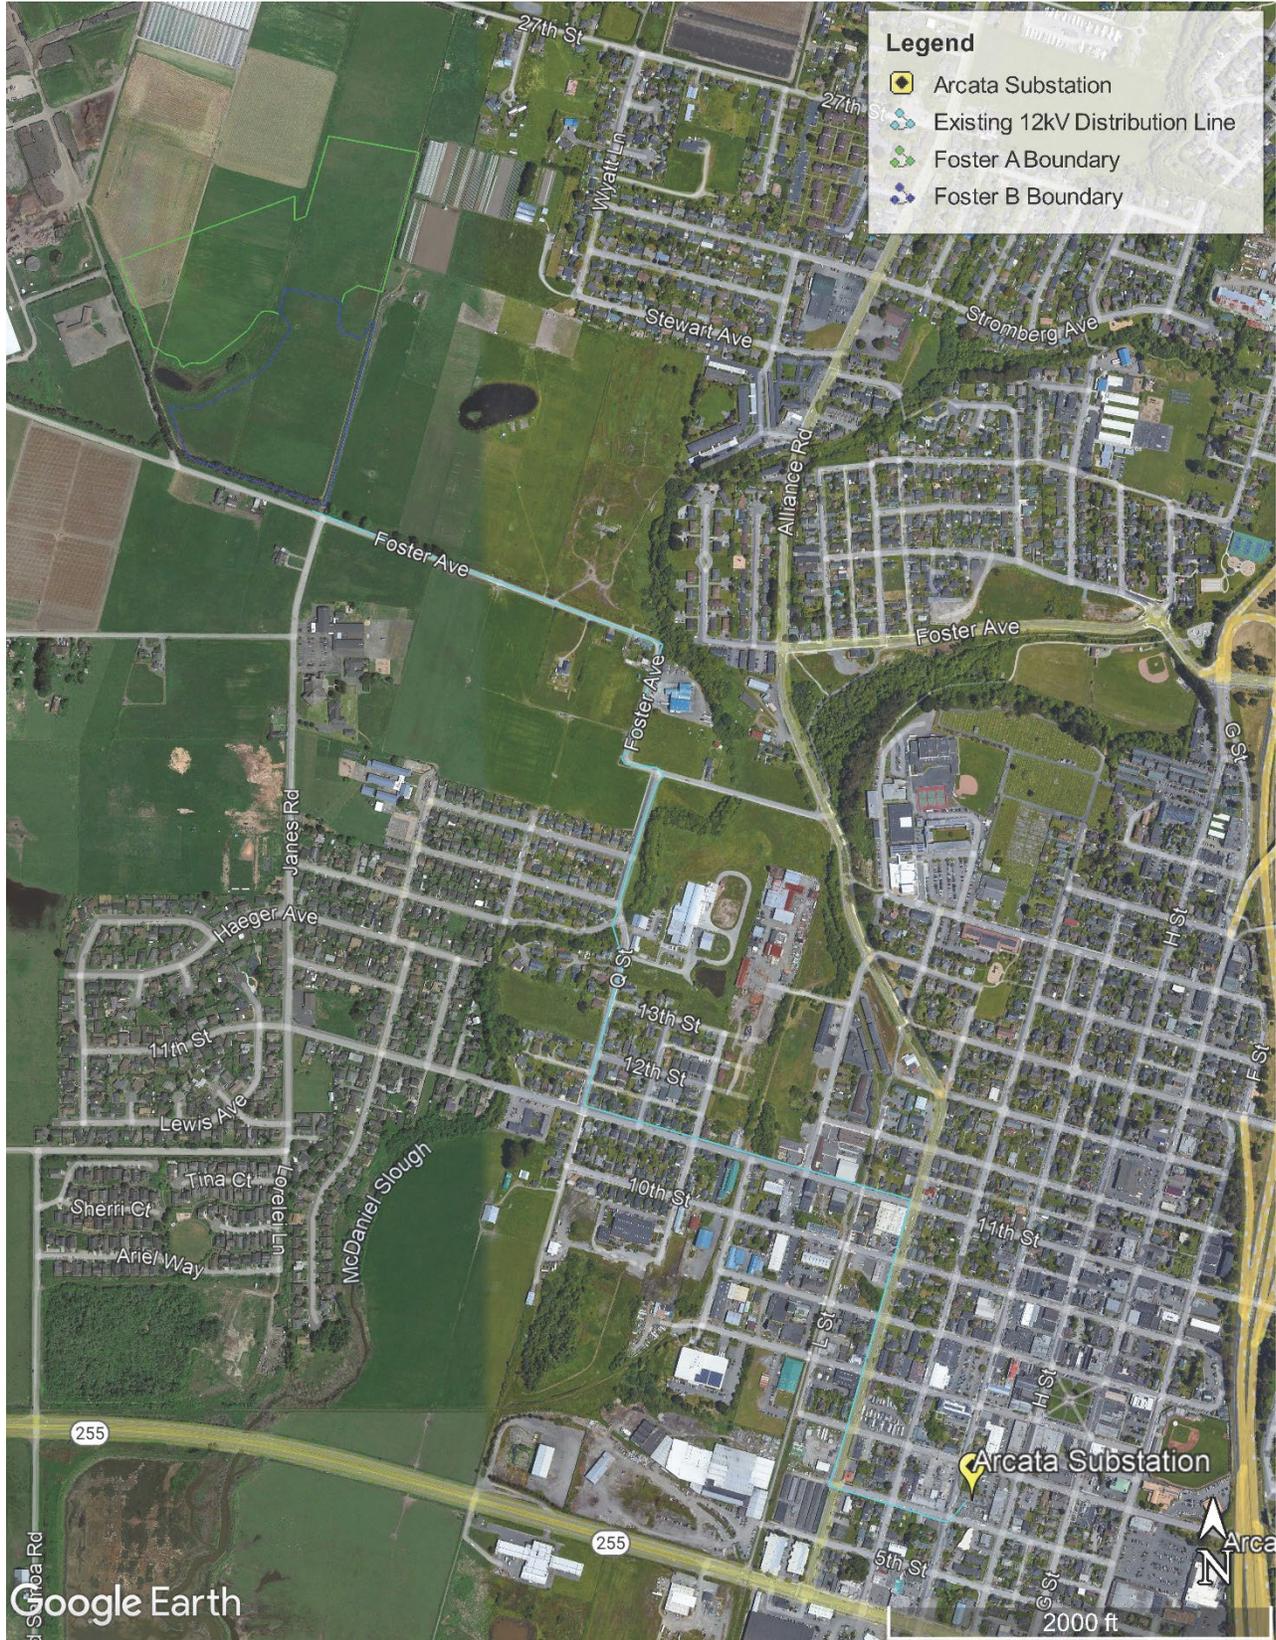Figure A-12 Existing Distribution Interconnection Route



APPENDIX A

Figure A-13 Drone Image 1 – North (April 15, 2021)



Figure A-14 Drone Image 2 – East (April 15, 2021)



APPENDIX A

Figure A-15 Drone Image 3 – South (April 15, 2021)



Figure A-16 Drone Image 4 – Southwest (April 15, 2021)



APPENDIX A

Figure A-17 Drone Image 5 – Southwest-West (June 10, 2021)



Figure A-18 Drone Image 6 – East (June 10, 2021)



APPENDIX A

Figure A-19 Example of a Battery Storage Unit and Equipment Housing



Figure A-20 Location of Anticipated Tree Removal on Foster Avenue

